## ELECTRICAL NOTES:

ELECTRICAL CONTRACTOR SHALL FURNISH ALL MATERIALS AND EQUIPMENT AND PERFORM ALL WORK AS REQUIRED FOR COMPLETE AND PROPERLY FUNCTIONING ELECTRICAL SYSTEMS AS INDICATED ON THE DRAWINGS AND AS EVIDENTLY NECESSARY FOR THE SATISFACTORY COMPLETION OF THE PROJECT, WHETHER OR NOT EVERY SUCH ITEM IS SPECIFICALLY SHOWN ON THE DRAWINGS.

ALL WORK SHALL COMPLY WITH THE REQUIREMENTS OF THE NATIONAL ELECTRICAL CODE AS WELL AS ALL APPLICABLE LOCAL AND STATE CODES AND ORDINANCES. CONTRACTOR SHALL SECURE AND PAY FOR ALL REQUIRED PERMITS, FEES, INSPECTIONS, ETC.

ALL EQUIPMENT AND MATERIALS SHALL BE AS SPECIFIED, OR AS APPROVED BY THE ENGINEER. ALL MATERIALS SHALL BE NEW AND SHALL BE UL-APPROVED. CONTRACTOR SHALL SUBMIT ALL PROPOSED MATERIALS AND EQUIPMENT FOR APPROVAL PRIOR TO PURCHASE.

. CONTRACTOR SHALL FULLY TEST ALL WIRING FOR CONTINUITY, AND ALL CIRCUITS AND EQUIPMENT FOR PROPER FUNCTION. ALL WORK,
MATERIALS, AND EQUIPMENT SHALL BE WARRANTIED FOR A PERIOD OF ONE YEAR FROM THE DATE OF FINAL ACCEPTANCE OF THE PROJECT.
UPON COMPLETION OF THE PROJECT, THE CONTRACTOR SHALL DELIVER TO THE OWNER COMPLETE OPERATION AND MAINTENANCE MANUALS, IN

5. ALL SYSTEMS, CIRCUITS, AND EQUIPMENT INSTALLED OR CONNECTED ON THE PROJECT SHALL BE PROPERLY GROUNDED IN ACCORDANCE WITH THE NEC. SERVICE GROUNDING ELECTRODE CONDUCTORS SHALL BE CONNECTED TO GROUNDED BUILDING STRUCTURE, MAIN WATER LINE, AND OTHER AVAILABLE ELECTRODES. SUPPLEMENTAL "MADE" ELECTRODES SHALL BE PROVIDED AS REQUIRED. ALL FEEDERS AND CIRCUITS SHALL INCLUDE A SEPARATE GROUNDING CONDUCTOR SIZED ACCORDING TO NEC TABLE 250-95.

ALL WIRING SHALL BE INSTALLED IN CONDUIT, UNLESS SPECIFICALLY SHOWN OR APPROVED OTHERWISE. NON-METALLIC CONDUIT MAY BE USED FOR INSTALLATION UNDERGROUND OR IN POURED CONCRETE. OTHERWISE, CONDUIT SHAL BE OF METAL. USE HEAVY WALL STEEL CONDUIT OR IMC FOR CONDUITS 2 1/2" IN DIAMETER OR LARGER, AND FOR CONDUITS EXPOSED BELOW 48" A.F.F. OR OTHERWISE SUBJECT TO DAMAGE. USE EMT FOR GENERAL INTERIOR BRANCH CIRCUITING APPLICATIONS. EMT SHALL BE INSTALLED WITH COMPRESSION TYPE FITTINGS OF STEEL. CONNECTORS SHALL HAVE INSULATED THROATS.

USE FLEXIBLE METAL CONDUIT FOR CONNECTIONS TO MOTORS, TRANSFORMERS, AND OTHER VIBRATING EQUIPMENT, AND FOR FINAL CONNECTION TO LIGHTING FIXTURES IN SUSPENDED CEILINGS. USE LIQUID-TIGHT FLEXIBLE METAL CONDUIT FOR WET OR DAMP LOCATIONS.

BOXES SHALL BE OF STEEL OR ALUMINUM. ALL BOXES SHALL BE INSTALLED SECURELY AND PERFECTLY LEVEL. BOXES RECESSED IN WALLS OR OTHER SURFACES SHALL BE SET TO BE FLUSH WITH THE FINISHED

ALL CONDUCTORS SHALL BE OF COPPER, WITH 600V INSULATION TYPE THHN\THWN, EXCEPT WHERE CODES REQUIRE DIFFERENT TYPE. MINIMUM SIZE SHALL BE #12 AWG, EXCEPT FOR CONTROL AND SIGNAL WIRING WHICH MAY USE \$16 AWG MINIMUM. CONDUCTORS SHALL BE COLOR-CODED BLACK, RED, BLUE, WHITE, AND GREEN ( PHASES A, B, C, NEUTRAL, AND GROUND ).

10. CONDUCTORS #10 AWG AND SMALLER SHALL BE SOLID, WITH INSULATION COLORED IN MANUFACTURE. MAKE CIRCUIT JOINTS WITH TWIST-ON INSULATED CONNECTORS ( WIRENUTS ). CONDUCTORS #8 ANG AND LARGER SHALL BE STRANDED. MAKE JOINTS WITH SPLIT-BOLTS OR OTHER MECHANICAL-PRESSURE TYPE CONNECTORS.

11. CONDUCTOR SIZE SHALL BE AS NOTED ON THE DRAWINGS, OR OF THE APPROPRIATE SIZE TO MATCH CIRCUIT OVERCURRENT PROTECTION. WHERE THE LENGTH OF A 20A BRANCH CIRCUIT ( MEASURED TO THE FARTHEST OUTLET ) EXCEEDS 75', CONTRACTOR SHALL ADJUST THE CONDUCTOR SIZE TO LIMIT VOLTAGE DROP ( eg. MINIMUM #10 ANG

WIRING DEVICES SHALL BE SPECIFICATION GRADE AS MANUFACTURED BY HUBBELL, SLATER, LEVITON, OR APPROVED EQUAL. DEVICES SHALL BE IVORY IN COLOR. TRIM PLATES SHALL BE OF #302 STAINLESS STEEL. ALL DEVICES AND PLATES SHALL MATCH THROUGHOUT THE PROJECT. DUPLEX RECEPTACLES SHALL BE RATED 20A, 125V, 3-WIRE GROUNDING TYPE. LIGHTING SWITCHES SHALL BE RATED 20A, 120-277V, WITH GROUNDING SCREW. SPECIAL-PURPOSE DEVICES SHALL BE FURNISHED AS INDICATED OR REQUIRED TO ACCOMMODATE THE EQUIPMENT

13. LIGHTING FIXTURES SHALL BE FURNISHED AND INSTALLED AS INDICATED ON THE DRAWINGS. FIXTURES SHALL BE FURNISHED COMPLETE WITH LAMPS, AND ALL HARDWARE AND ACCESSORIES AS REQUIRED TO PROPERLY SUPPORT AND FIT THEM TO THE OCTION. FLUORESCENT FIXTURES SHALL BE FURNISHED WITH ENERGY-SAVING LAMPS AND BALLASTS. ALL FIXTURES SHALL BE SUPPORTED FROM THE STRUCTURE.

14. PANELBOARDS SHALL BE OF COMMERCIAL GRADE AS MANUFACTURED BY SQUARE D, GENERAL ELECTRIC, OR WESTINGHOUSE. PANEL TYPES SPECIFIED ARE THOSE OF SQUARE D AND ARE INTENDED TO ESTABLISH TYPE AND QUALITY REQUIRED. PANELS SHALL BE FURNISHED WITH COPPER BUSSES. EACH PANEL SHALL BE EQUIPPED WITH A COPPER EQUIPMENT GROUNDING BAR. PANEL ENCLOSURES SHALL BE FORNISHED WITH BLANK ENDWALLS. CIRCUIT BREAKERS SHALL BE BOLT-ON MOLDED-CASE TYPE, WITH THERMAL-MAGNETIC TRIPS. MULTI-POLE BREAKERS SHALL HAVE COMMON INTERNAL TRIP. HANDLE TIES ARE NOT PERMITTED. CIRCUIT BREAKERS USED FOR CONTROL OF


LIGHTING LOADS OR OTHER FREQUENT SWITCHING DUTY SHALL BE RATED FOR THE APPLICATION.

5. ALL CIRCUIT BREAKERS SHALL BE ARRANGED AND NUMBERED AS SHOWN AND ALL CIRCUITS SHALL BE CONNECTED AS ASSIGNED ON THE PLAN DRAWINGS. EACH PANELBOARD SHALL BE FURNISHED WITH A TYPED DIRECTORY CARD IDENTIFYING THE LOAD CONNECTED TO EACH BREAKER.


16. DISCONNECT SWITCHES SHALL BE FURNISHED AS SHOWN ON THE DRAWINGS AND AS REQUIRED TO COMPLY WITH CODES. SWITCHES SHALL BE GENERAL DUTY SAFETY SWITCHES, OF AMPERAGE, VOLTAGE, AND CONFIGURATION REQUIRED. FUSIBLE SWITCHES SHALL BE EQUIPED WITH FUSES - CLASS RK5 TIME-DELAY UNLESS NOTED OTHERWISE. FURNISH NEMA IR ENCLOSURES FOR SWITCHES IN WET LOCATIONS, AND OTHER SPECIAL ENCLOSURES AS APPROPRIATE.

CONTRACTOR SHALL COORDINATE WITH THE TELEPHONE UTILITY TO ACCOMMODATE TELEPHONE SERVICE TO THE PROJECT. UNLESS NOTED OTHERWISE, PROVIDE 2 1/2"C SCHEDULE 40 PVC CONDUIT FROM PROPERTY LINE TO EQUIPMENT LOCATION FOR ENTRANCE OF TELEPHONE UTILITY SERVICE CABLE. AT EACH OUTLET LOCATION, PROVIDE 4" SQUARE OUTLET BOX WITH SINGLE DEVICE RING. PROVIDE 3/4"C FROM EACH OUTLET TO THE EQUIPMENT LOCATION. LEAVE ALL CONDUITS

. CONTRACTOR SHALL COORDINATE WITH THE POWER UTILITY COMPANY FOR POWER SERVICE TO THE PROJECT. INSTALL METERING EQUIPMENT, ETC. AS REQUIRED. IF PADMOUNT TRANSFORMER IS USED, PROVIDE CONCRETE PAD IN ACCORDANCE WITH UTILITY SPECIFICATIONS.

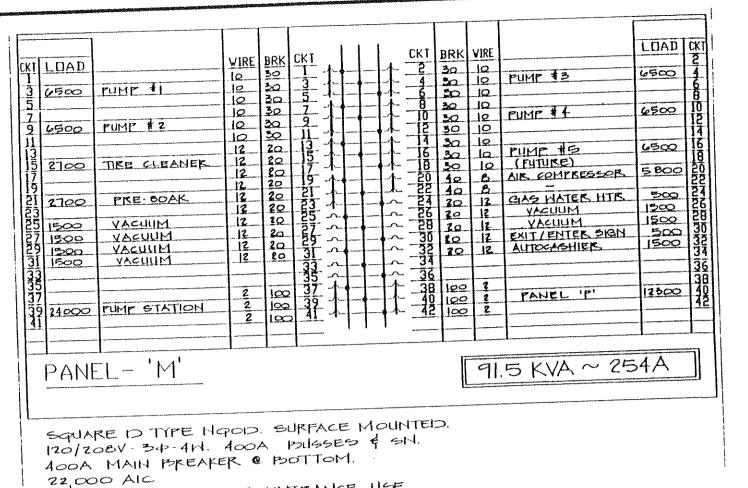

UL LABEL FOR SERVICE ENTRANCE USE.

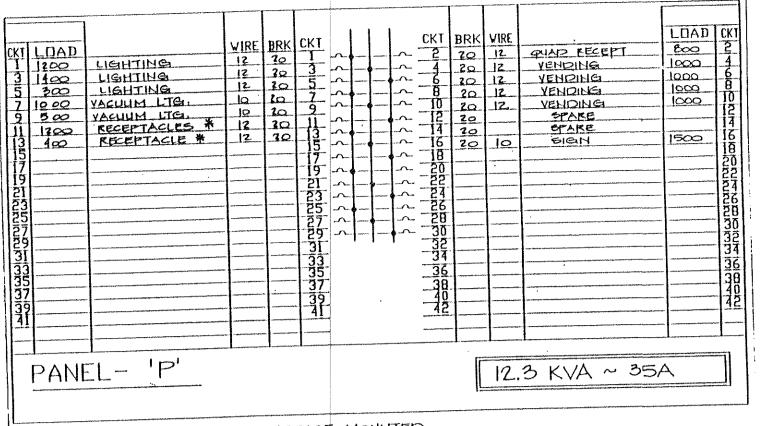

SQUARE D TYPE NOOD, SURFACE MOUNTED. 120/2084. 34.4W. 100A BUSSES & EN. MAIN LUGG ONLY @ BOTTOM.

22,000 AIC. \* GFI CIRCUIT BREAKER.

## SYMPOL SCHEDULE

PART PROOF WET LOCATION, ENCLOSED LIGHTING FIXTURE - LITHONIA DMW296

WALL MOUNTED WALL PACK METAL HALIDE - 250M - LITHONIA THP WALL PACK

BHITCH , 20A, ST 120-277V

DUPLEX FECEPTACLE - 20A 125V 3 WIFE GROUNDING TIPE


DIFLEX RECEPTACLE - 20A 125V 3 MIRE GIND TIPE M/ POULLT IN (1) eiti GROUND FAULT PROTECTION

DIFLEX RECEPTACLE 20A 125V 3-WIRE GROUNDING TYPE, WEATHERPROOF COVER O ME

DISCONNECT SWITCH FUSED

MACULIM ISLAND LIGHT POLE & LIGHTS 

EXHAUGT FAN & LIGHT COMPOINATION

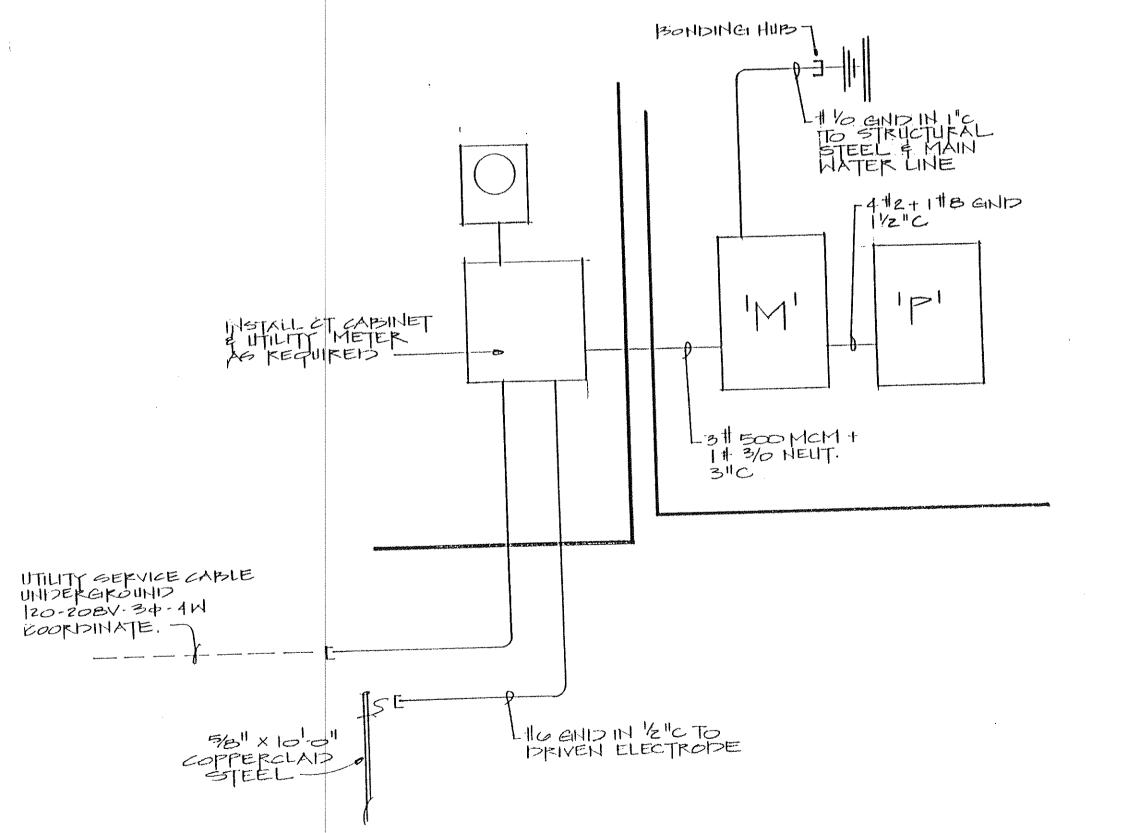

ELECTRICAL RISER DIAGRAM


Quality

esign

97 (800)

DATE 2/3/98 DRAWN BY: DAF SCALE: AS NOTED REVISED:

APPROVED: Sheet No.

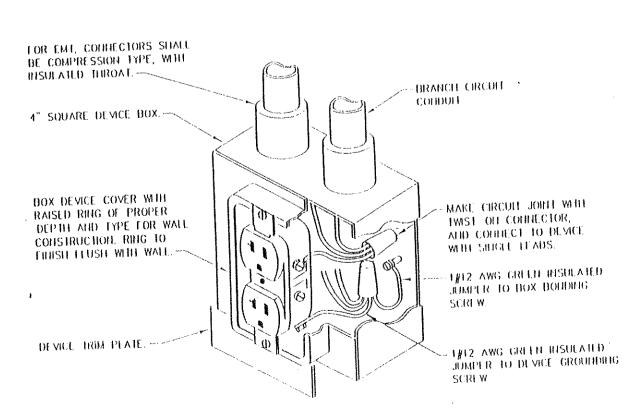

DETAIL - TYPICAL DUPLEX RECEPTACLE INSTALLATION